

ATTACHMENT 'D' – COCKSHUTT ROAD SIDEWALK DRAWINGS

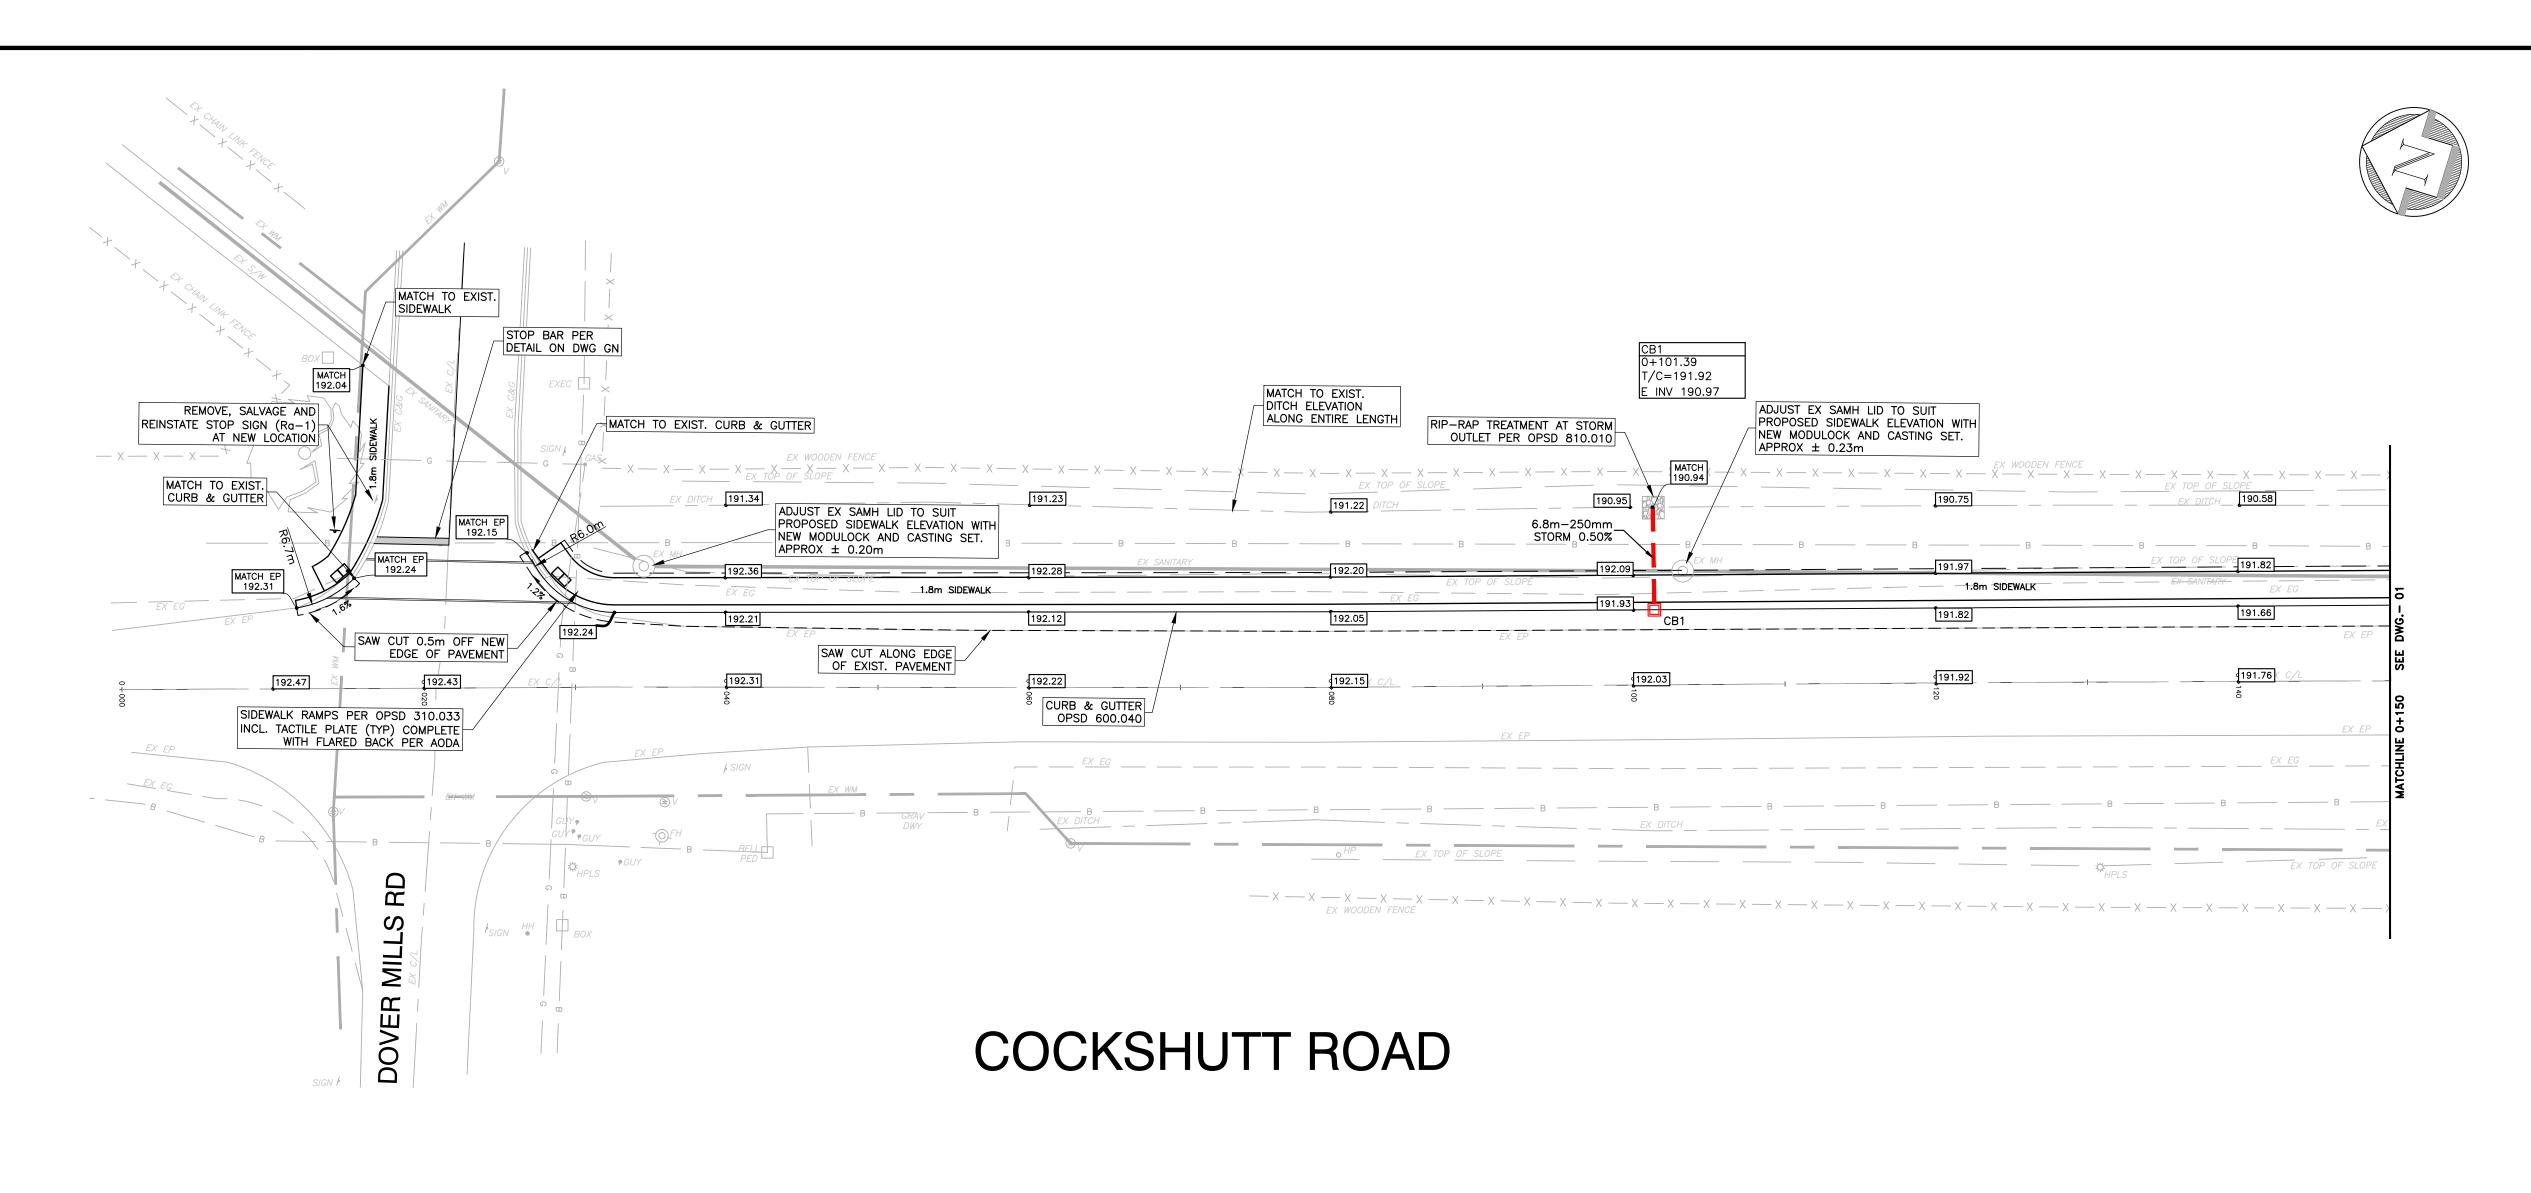

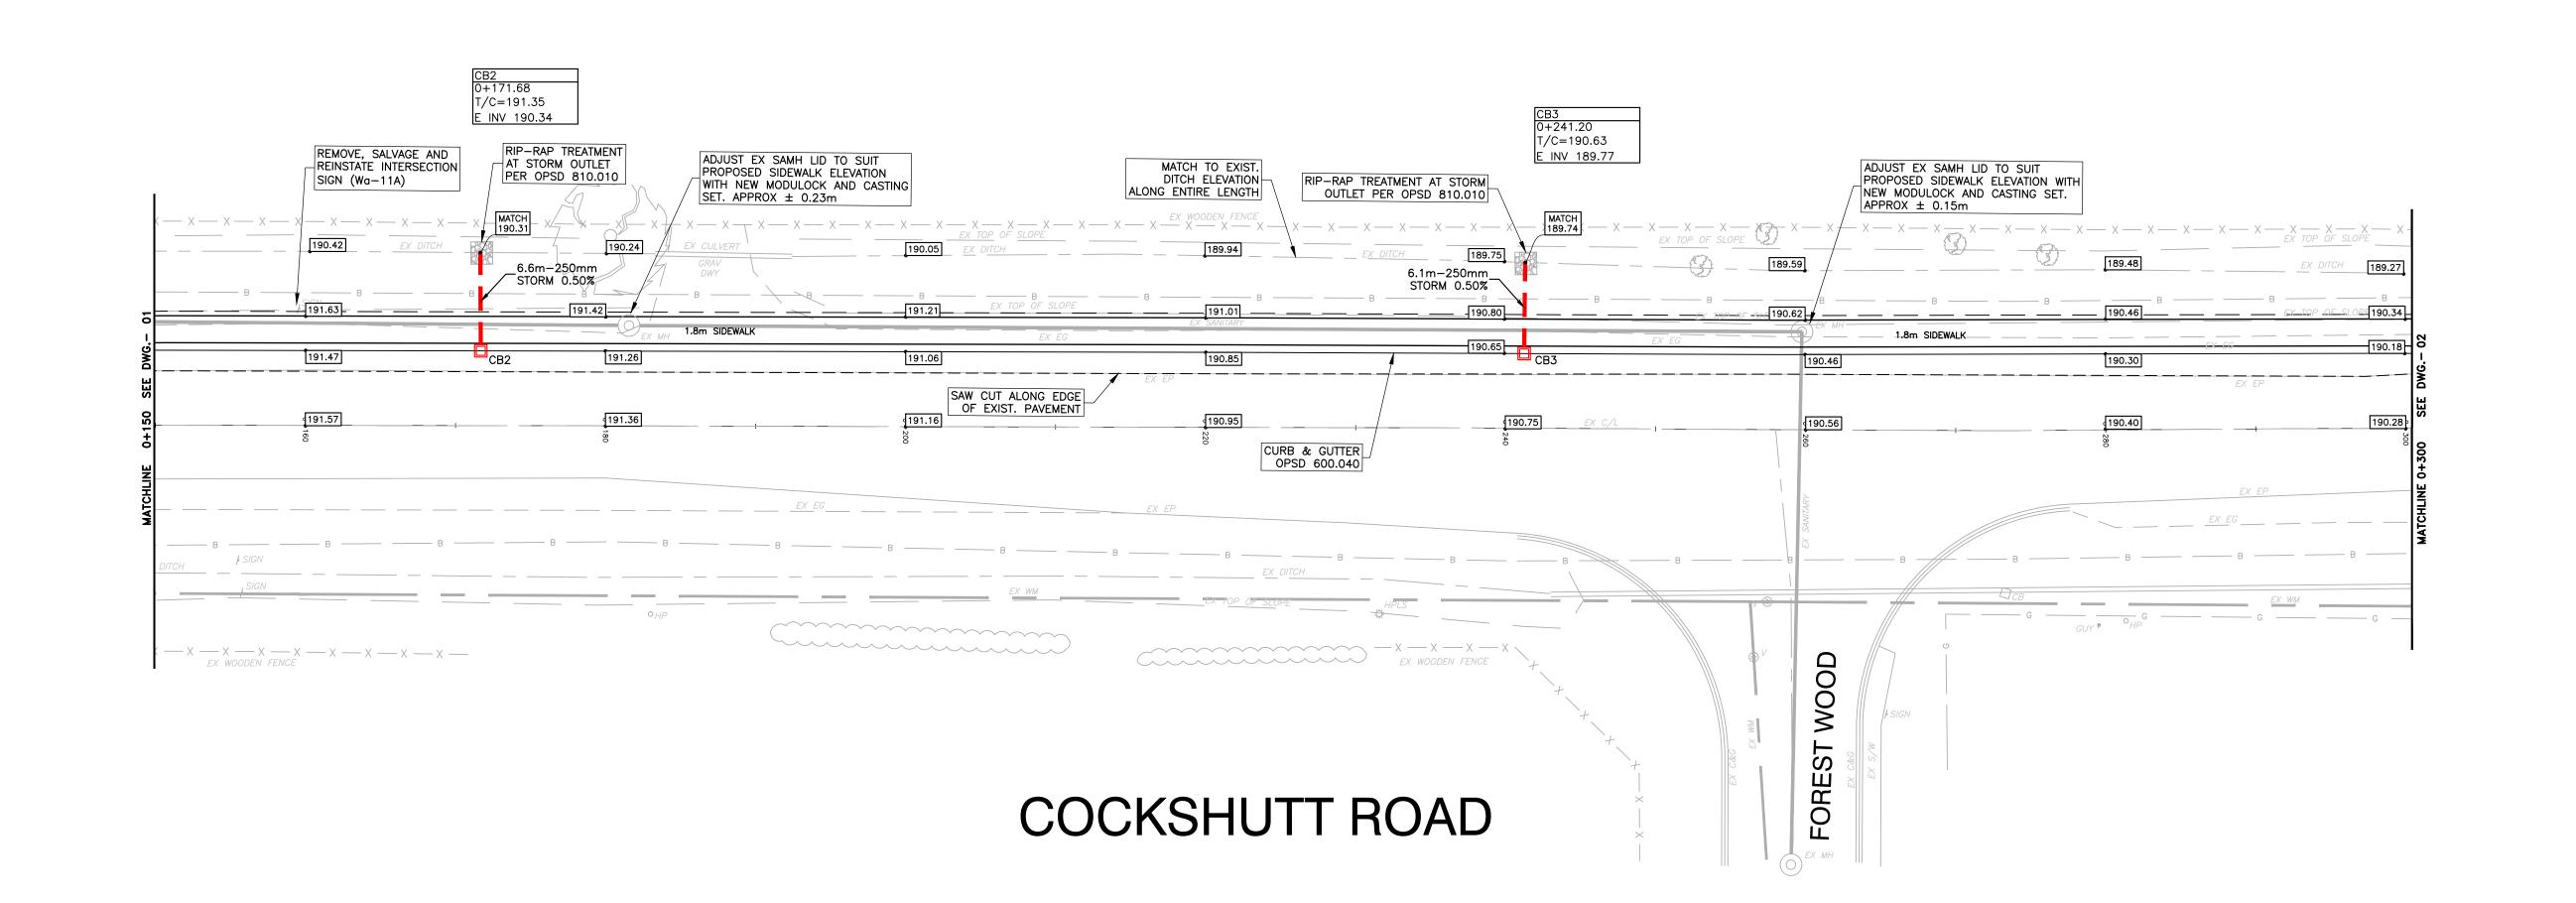

REV. No.	DATE	REVISION				
0	DEC 06/21	ISSUED FOR COUNTY REVIEW				

NOTE:
THE CONTRACTOR IS CAUTIONED THAT ALL OF THE EXISTING UTILITIES ARE NOT INDICATED ON THIS DRAWING. THE CONTRACTOR MUST ARRANGE FOR LOCATES FROM EACH AREA UTILITY COMPANY PRIOR TO ANY CONSTRUCTION OR EXCAVATION. THE CONTRACTOR SHALL BE SOLELY RESPONSIBLE FOR THE PROTECTION OF ALL UTILITIES INCLUDING THOSE NOT INDICATED ON THIS DRAWING. G. DOUGLAS VALLEE LTD. CAN NOT ACCEPT RESPONSIBILITY FOR DAMAGE TO ANY EXISTING UTILITY WHICH MAY MAY OR MAY NOT BE INDICATED ON THIS DRAWING.

SCALE: 1:250 0 5 10 15



G. DOUGLAS VALLEE LIMITED
2 TALBOT STREET NORTH
SIMCOE, ONTARIO N3Y 3W4
(519) 426-6270

Stamp

COCKSHUTT ROAD

SIDEWALK
PORT DOVER - NORFOLK COUNTY
EIS-ENG-22-##

STA. 0+000 - 0+300 COCKSHUTT RD.

Designed by:

TGS

TGS

NL

Checked by:

TGS

Date Started:


JULY 202


Drawing Scale:


AS NOTED


Drawing No.


Project No. 21-055-30

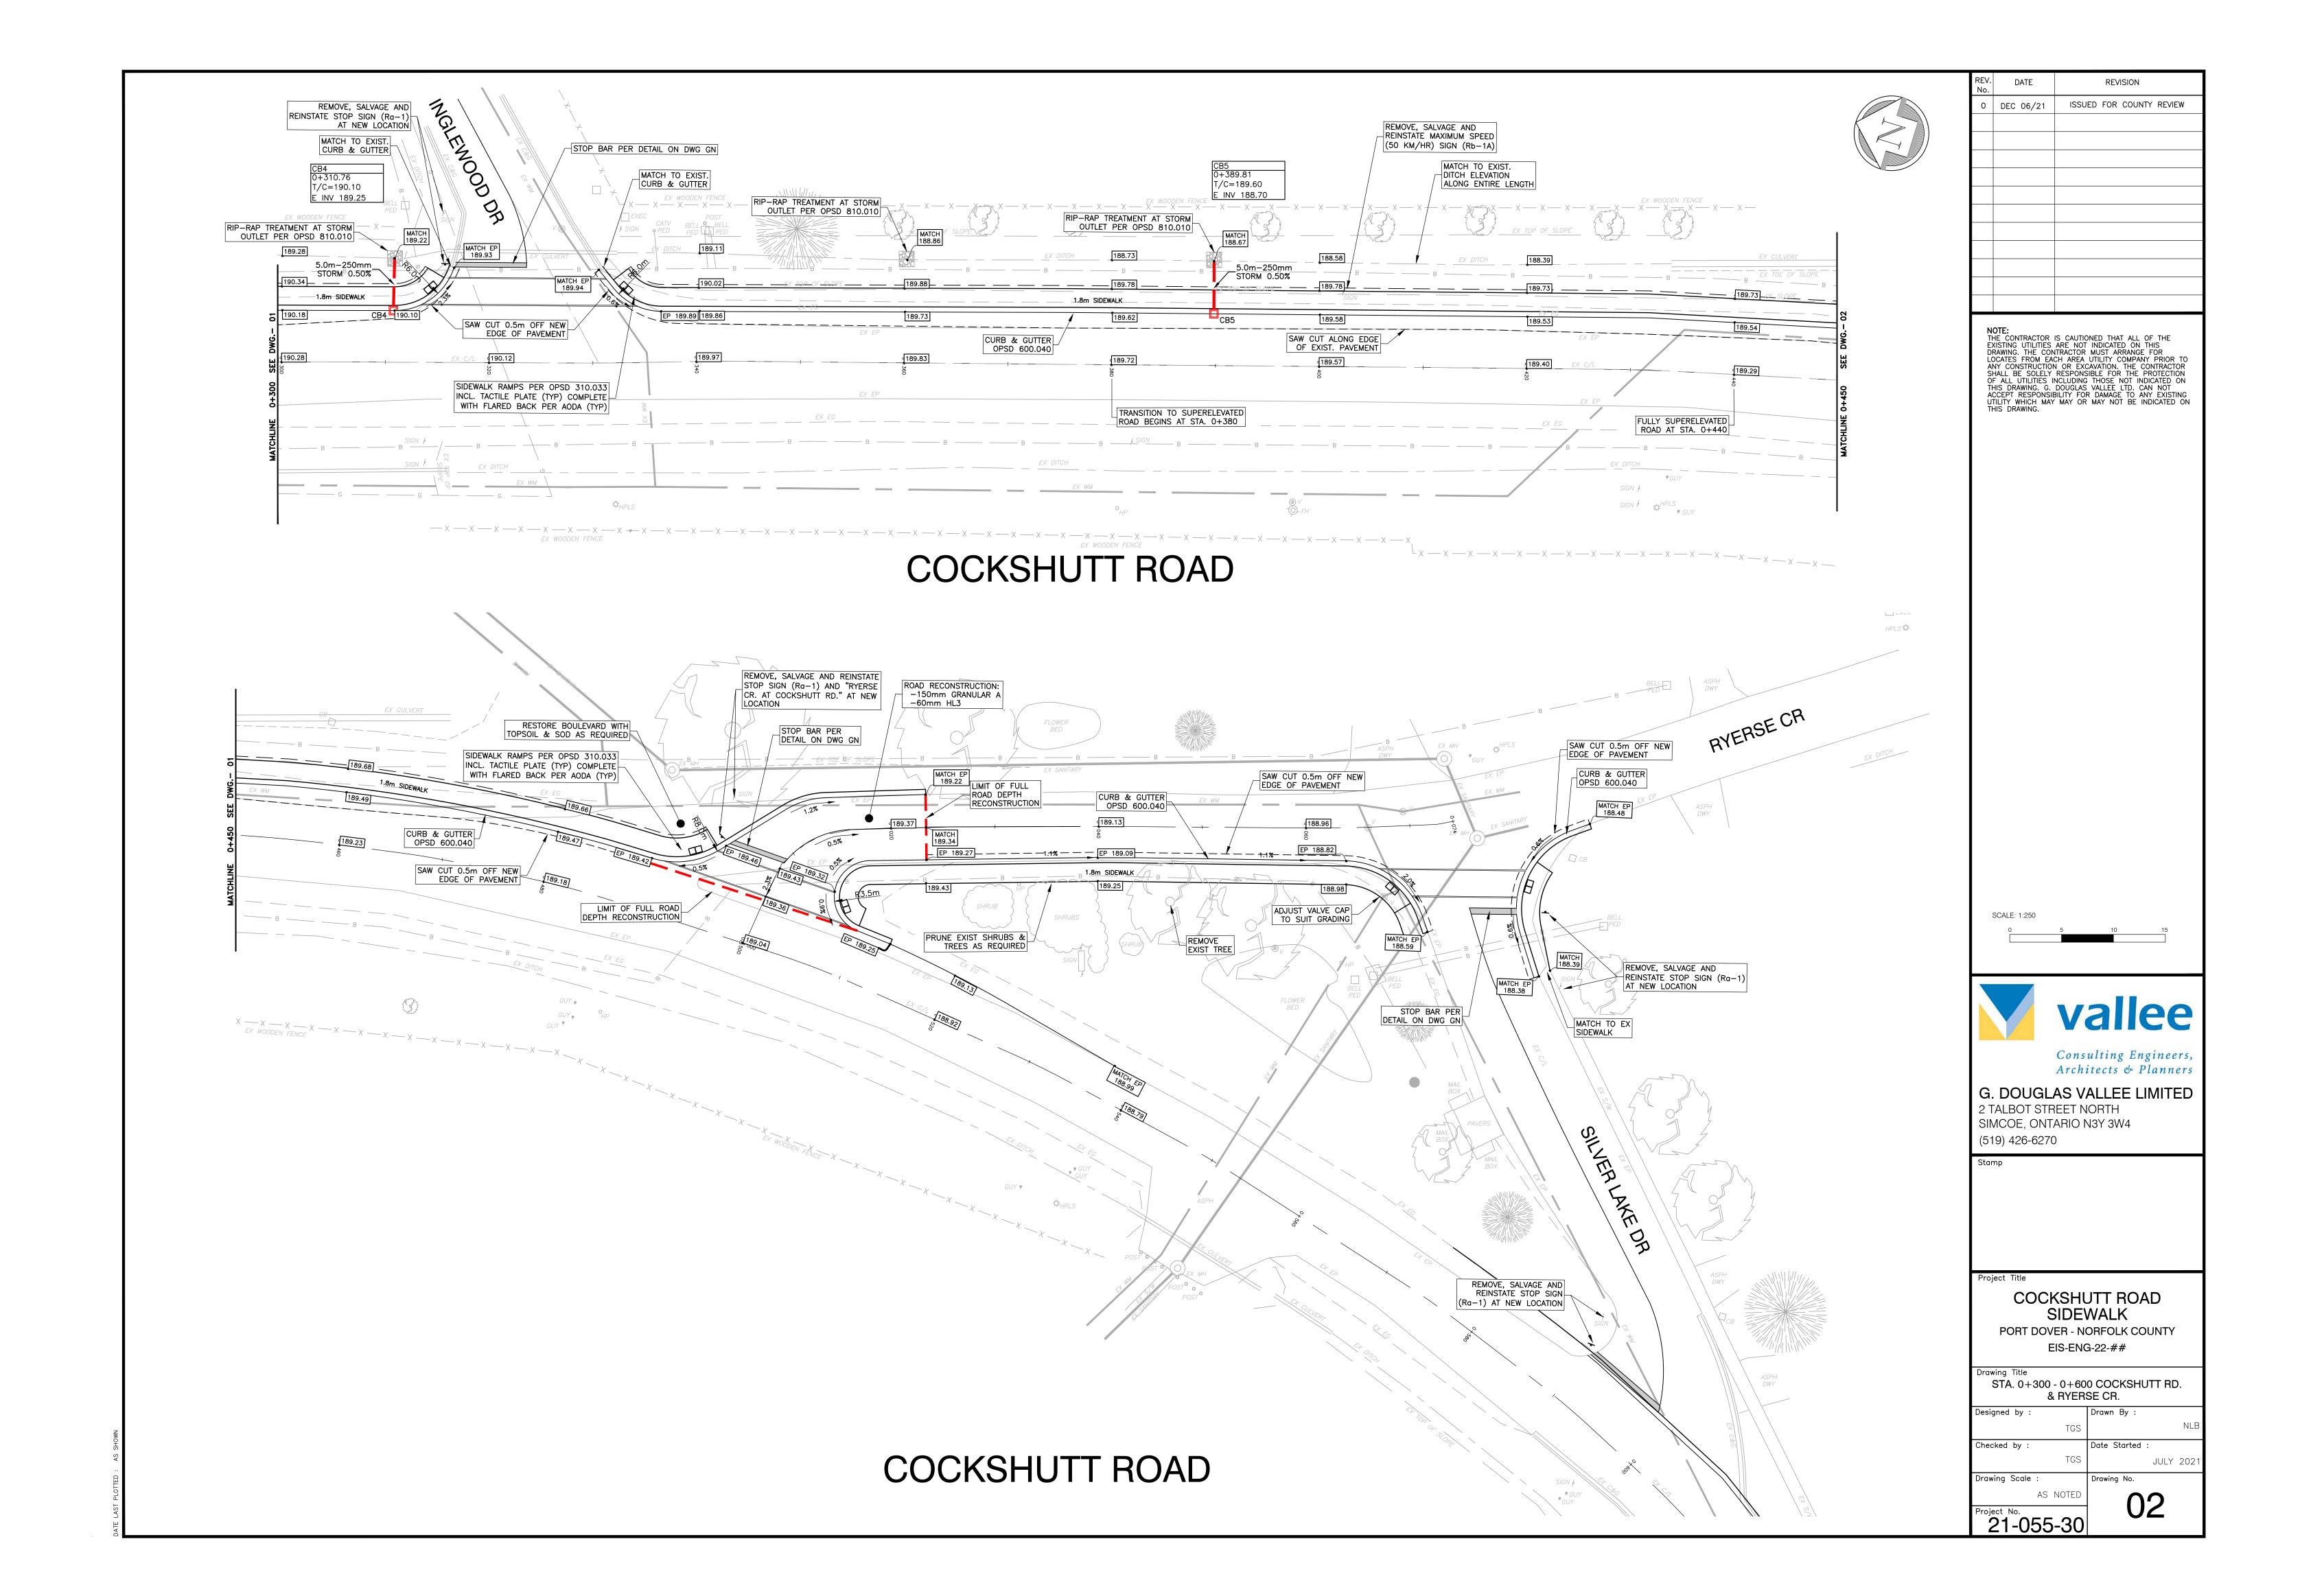


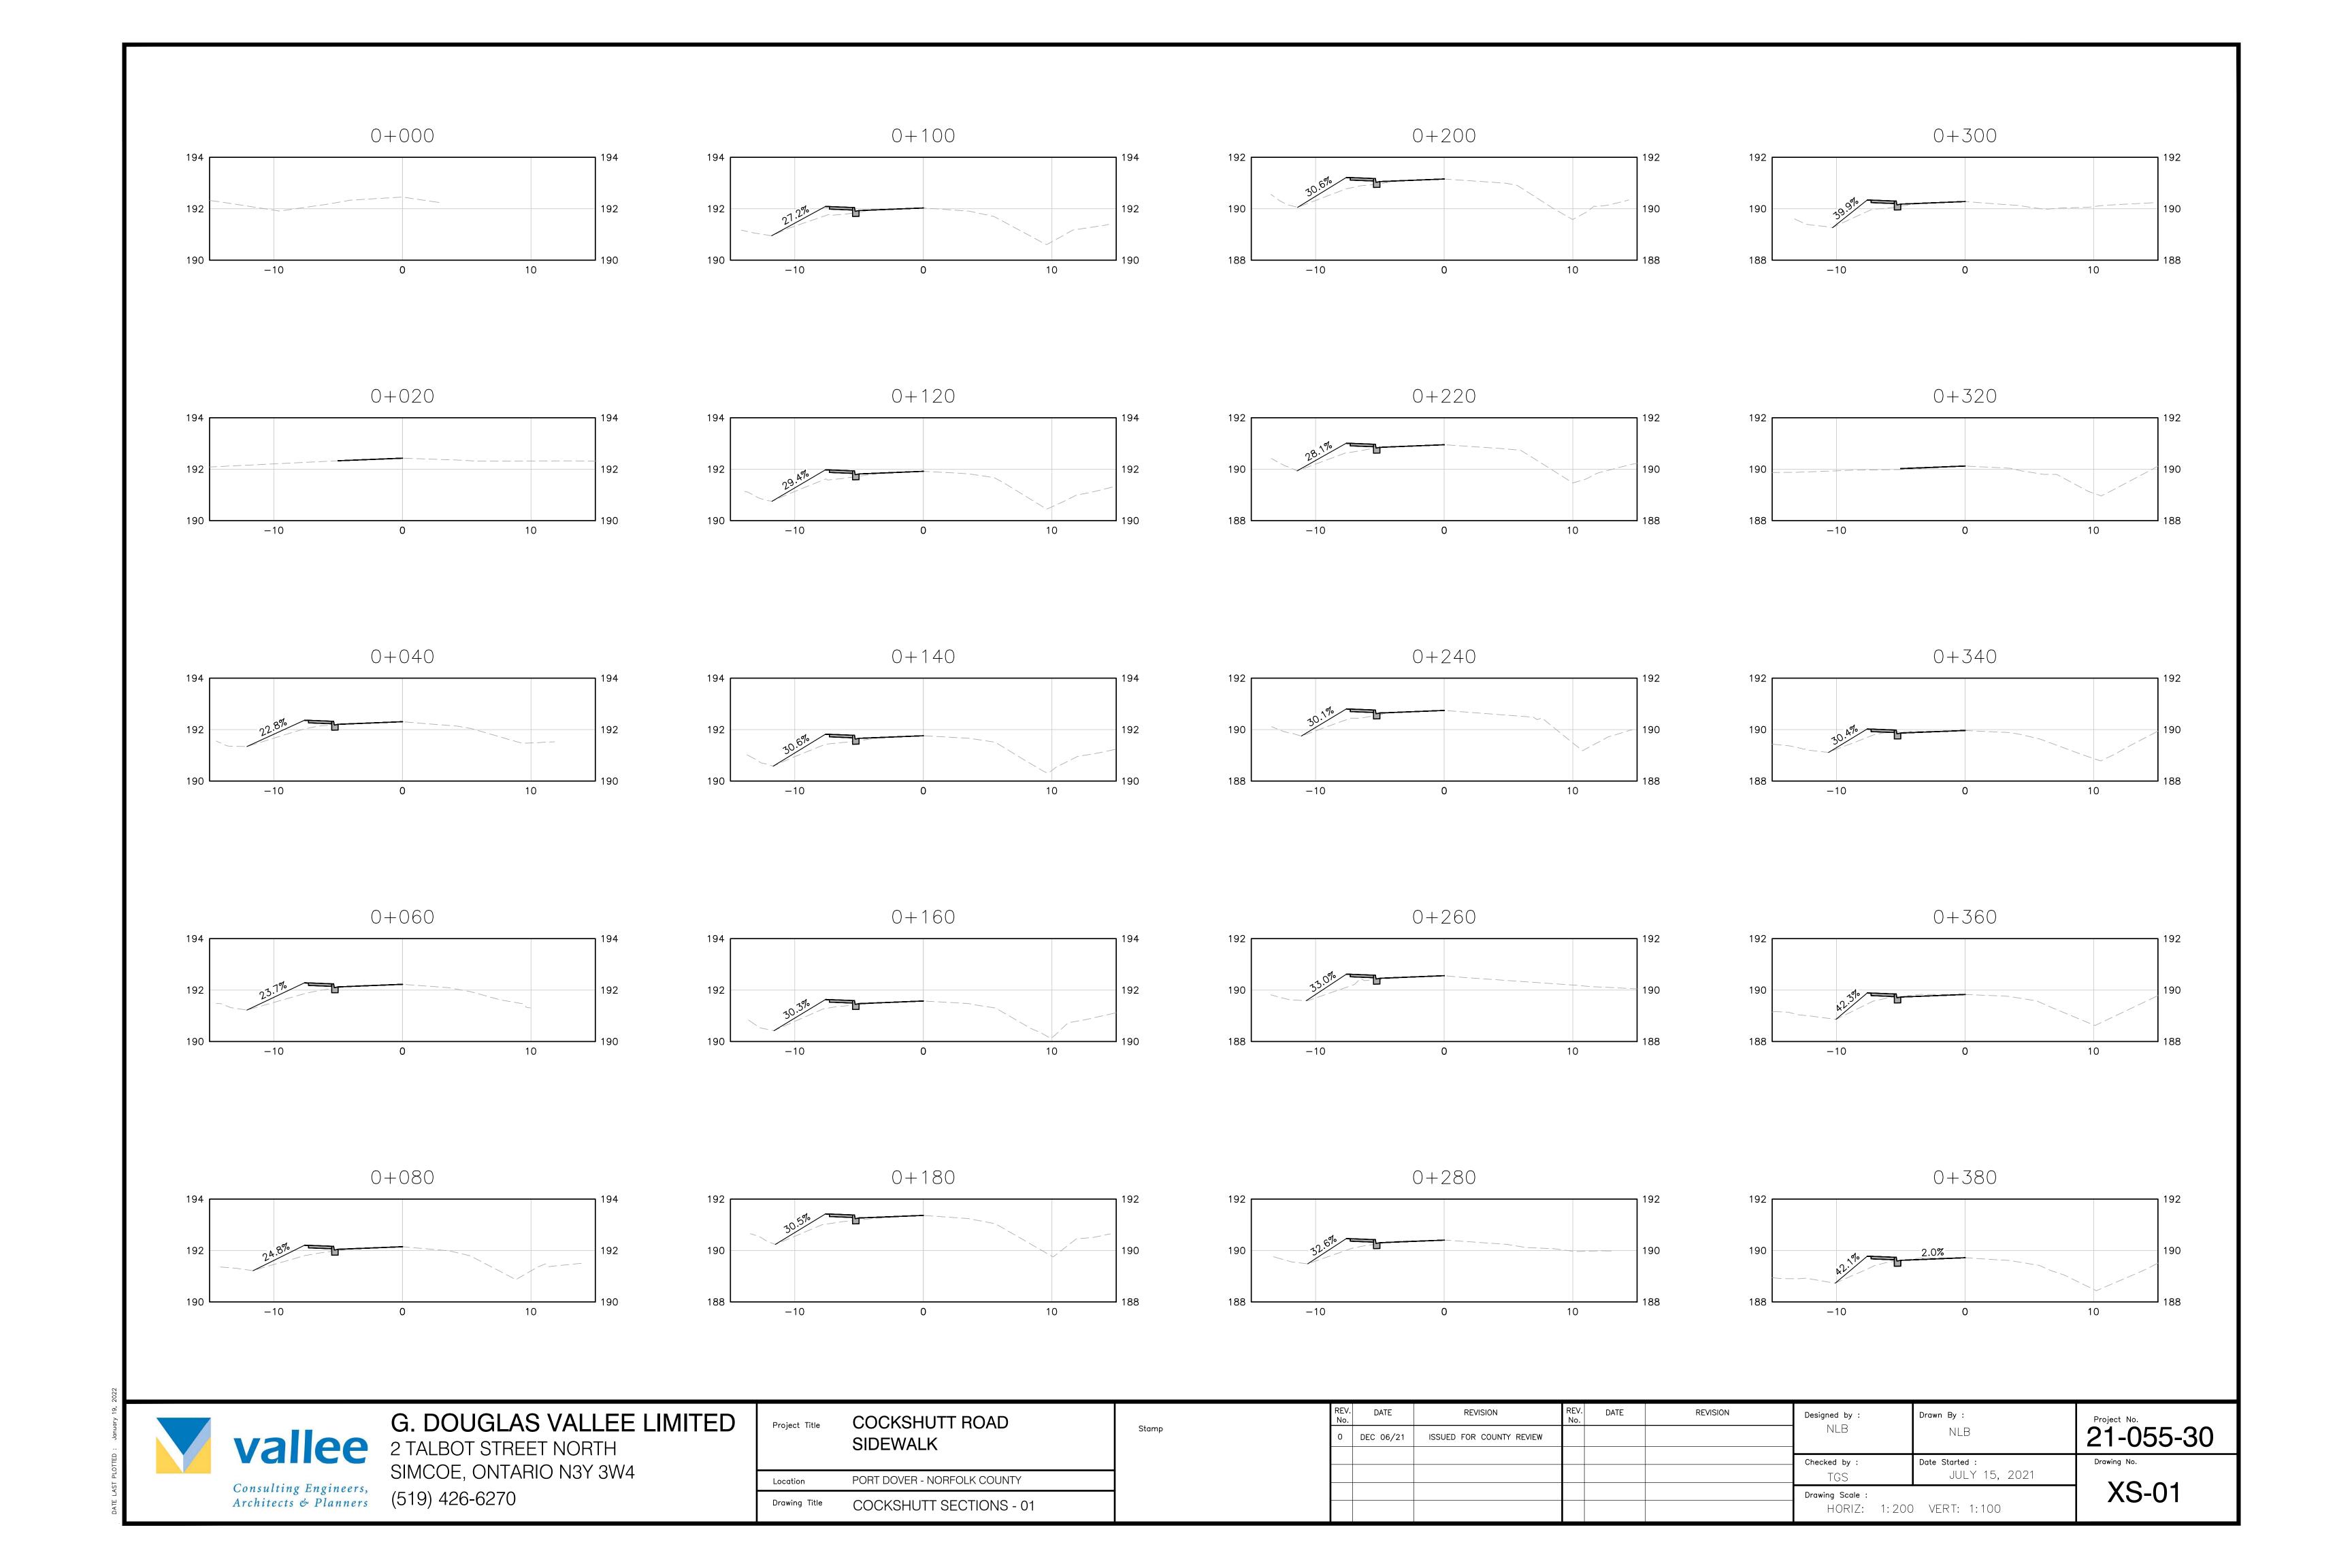


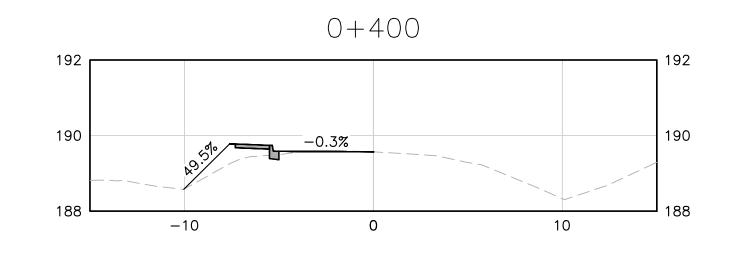


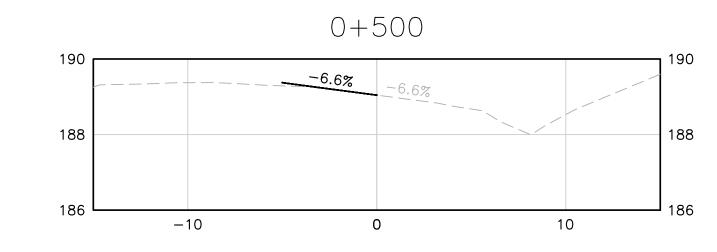

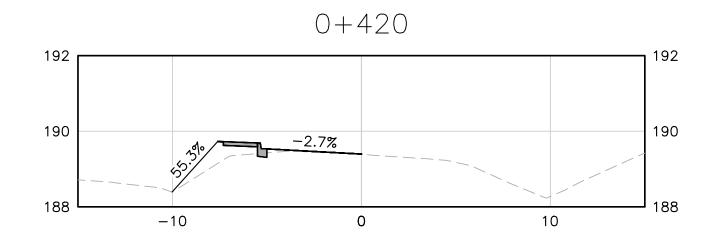


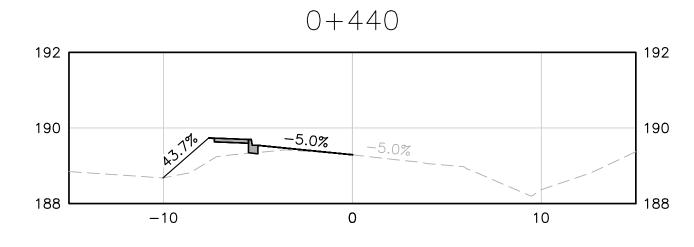


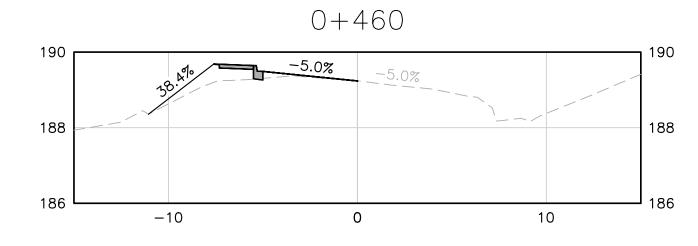


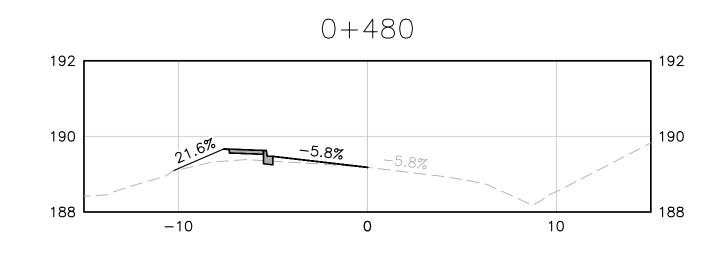

RYERSE CRESCENT SECTIONS

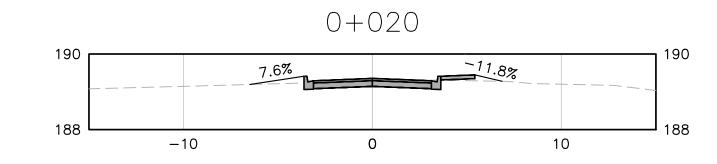

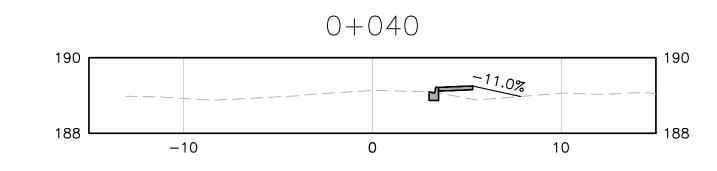

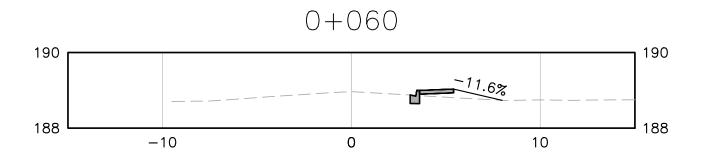



Vallee

G. DOUGLAS VALLEE LIMITED

2 TALBOT STREET NORTH
SIMCOE, ONTARIO N3Y 3W4

Project Title	COCKSHUTT ROAD SIDEWALK
Location	PORT DOVER - NORFOLK COUNTY
Drawing Title	COCKSHUTT SECTIONS - 02

REV. No.			REV. No.	DATE	REVISION	Designed by :	Drawn By :	Project No.
0	DEC 06/2	1 ISSUED FOR COUNTY REVIEW				NLB	NLB	21-055-30
						Checked by :	Date Started :	Drawing No.
						TGS	JULY 15, 2021	1/0 00
						Drawing Scale :	XS-02	
						HORIZ: 1:200 VERT: 1:100		

GENERAL NOTES

- 1. PRIOR TO CLOSING ANY STREET, THE CONTRACTOR SHALL OBTAIN CLEARANCE BY FILLING OUT THE COUNTY'S NOTICE OF ROAD CLOSURE FORM AND NOTIFY SCHOOL BUS OPERATORS OF STREETS USED FOR DETOUR AND THE DURATION OF THE DETOUR. THE CONTRACTOR MUST SUPPLY AND MAINTAIN ADEQUATE LOCAL DETOUR SIGNS AND LIGHTS. THE CONTRACTOR MUST MAINTAIN MAXIMUM ACCESS TO ALL PROPERTIES AS DIRECTED BY THE ENGINEER.
- 2. THE CONTRACTOR SHALL CONSTRUCT TEMPORARY MEASURES TO CONTROL SILT ENTERING THE STORM DRAINAGE SYSTEM TO THE SPECIFICATIONS OUTLINED IN THE GUIDELINES ON EROSION AND SEDIMENT CONTROL FOR URBAN CONSTRUCTION SITES PREPARED BY THE MINISTRY OF NATURAL RESOURCES. THESE MEASURES ARE TO BE INSTALLED PRIOR TO COMMENCING ANY CONSTRUCTION FOR THIS STREET AND ARE TO REMAIN IN PLACE UNTIL CONSTRUCTION HAS BEEN COMPLETED TO THE SPECIFICATIONS OF THE ENGINEER.
- 3. THE CONTRACTOR IS TO MEET ALL THE REQUIREMENTS OF THE OWNERS OF THE UTILITIES ON THIS PLAN, AND MUST MAKE SATISFACTORY ARRANGEMENTS WITH THE UTILITY COMPANIES FOR CROSSING THEIR INSTALLATIONS AND FOR PROVIDING ADEQUATE PROTECTION DURING CONSTRUCTION.
- 4. PRIOR TO COMMENCING ANY CONSTRUCTION, ALL EXISTING UNDERGROUND UTILITIES SHALL BE LOCATED AND MARKED. ANY UTILITIES DAMAGED OR DISTURBED DURING CONSTRUCTION SHALL BE REPAIRED OR REPLACED TO THE SATISFACTION OF THE OWNER AT THE CONTRACTORS EXPENSE.
- 5. ALL ORGANIC, SUITABLE OR UNSUITABLE MATERIALS BENEATH THE ROAD ALLOWANCES MUST BE REMOVED AND THESE AREAS BACKFILLED WITH AN APPROVED FILL MATERIAL, ALL TO THE SATISFACTION OF THE ENGINEER.
- 6. PRIOR TO COMMENCING ANY CONSTRUCTION, ALL EXISTING SEWER OUTLET INFORMATION, BENCHMARKS, DIMENSIONS, ELEVATIONS AND GRADES MUST BE CHECKED AND VERIFIED AND ANY DISCREPANCIES REPORTED TO THE ENGINEER IMMEDIATELY.
- 7. ALL ALL CATCH BASIN LEADS FOR SINGLE CATCH BASINS SHALL BE 250mm HDPE WITH CLASS 'B' BEDDING, UNLESS OTHERWISE NOTED.
- 8. ALL CATCH BASINS SHALL BE PER OPSD 705.010.
- 9. ALL CATCH BASIN FRAME AND GRATE CASTINGS SHALL BE PER OPSD 400.110.
- 10. SUB DRAINS SHALL BE IN ACCORDANCE TO THE PROVISIONS OF OPSS 405 EXCEPT FOR THE FOLLOWING:
- 10.1. ALL SUB DRAINS SHALL BE POLYETHYLENE PIPE PRODUCTS PER OPSS 405.05.02.
 10.2. BEDDING AND BACKFILL MATERIAL SHALL BE GRANULAR "A" CRUSHED LIMESTONE.


GENERAL SEDIMENT CONTROL MEASURES


- 1. PROTECT ALL EXPOSED SURFACES AND CONTROL ALL RUNOFF DURING CONSTRUCTION
- 2. ALL EROSION CONTROL MEASURES TO BE IN PLACE BEFORE STARTING CONSTRUCTION AND REMAIN IN PLACE UNTIL RESTORATION IS COMPLETE
- 3. MAINTAIN EROSION CONTROL MEASURES DURING CONSTRUCTION
- 4. ALL COLLECTED SEDIMENT TO BE DISPOSED OF AT AN APPROVED LOCATION
- 5. MINIMIZE AREA DISTURBED DURING CONSTRUCTION
- 6. ALL DEWATERING TO BE DISPOSED OF IN AN APPROVED SEDIMENTATION BASIN
- 7. PROTECT ALL CATCHBASINS, MANHOLES AND PIPE ENDS FROM SEDIMENT INTRUSION WITH GEOTEXTILE (TERRAFIX 270R OR APPROVED EQUIVALENT)
- 8. KEEP ALL SUMPS CLEAN DURING CONSTRUCTION
- 9. PREVENT WIND-BLOWN DUST
- 10. STRAW BALES TO BE USED IN LOCALIZED AREAS AS SHOWN AND AS DIRECTED BY THE


ROAD & BOULEVARD RESTORATION


ALL DISTURBED AREAS SHALL BE RESTORED AS FOLLOWS:


- 1. BOULEVARDS SHALL BE RESTORED AS NOTED ON TYPICAL SECTIONS THIS PAGE.
- 2. GRAVEL DRIVEWAYS SHALL BE RESTORED WITH 150mm OF GRANULAR "A" (100% SPMDD)
- 3. CONCRETE DRIVEWAYS SHALL BE RESTORED WITH 150mm OF GRANULAR "A" (100% SPMDD) WITH 150mm OF CONCRETE (OPSS MIX. 30MPa MINIMUM)
- 4. ASPHALT DRIVEWAYS SHALL BE RESTORED WITH 150mm OF GRANULAR "A" (100% SPMDD) WITH 50mm OF HL3 ASPHALT (97% MARSHALL)

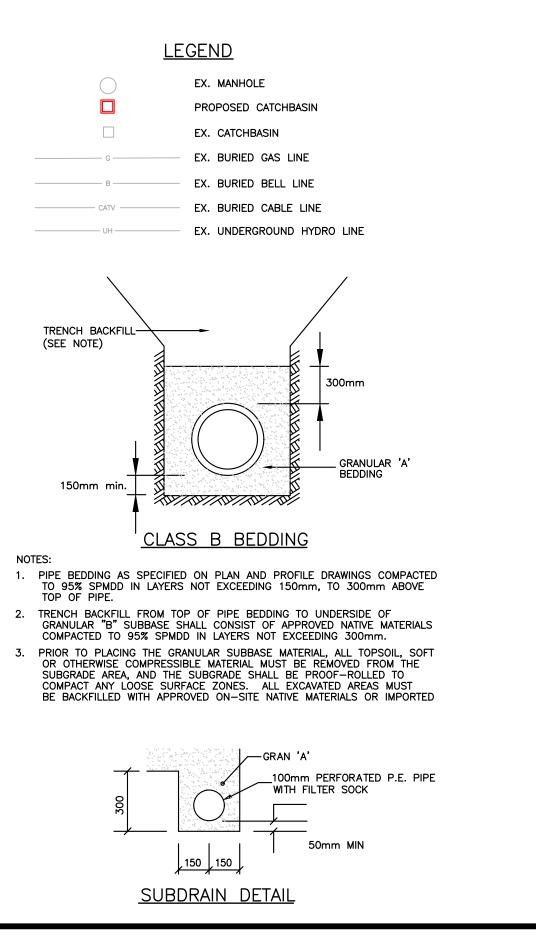

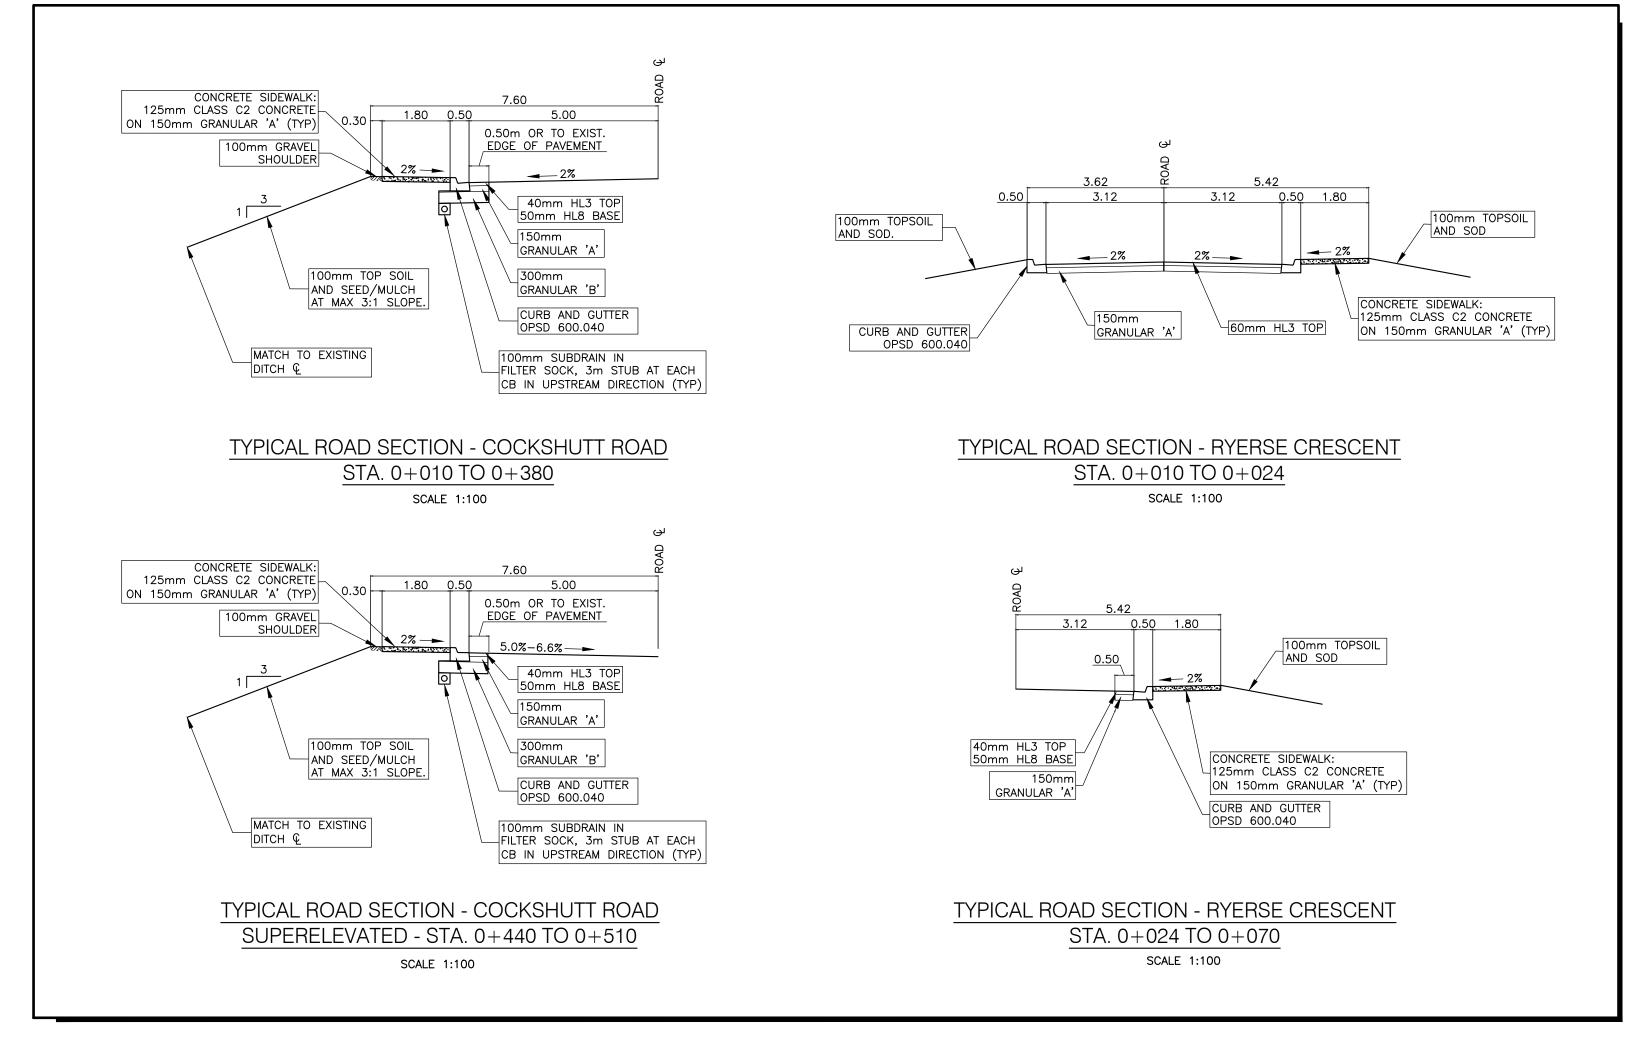

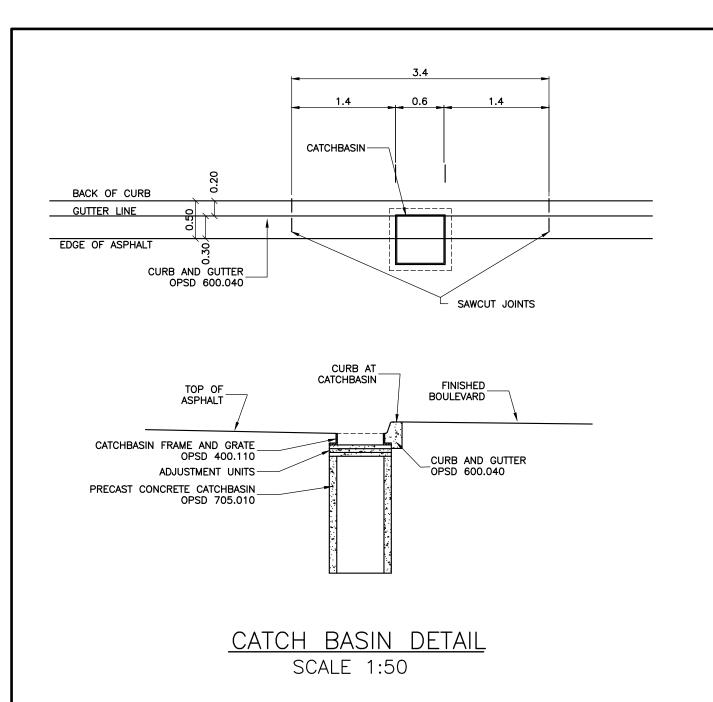

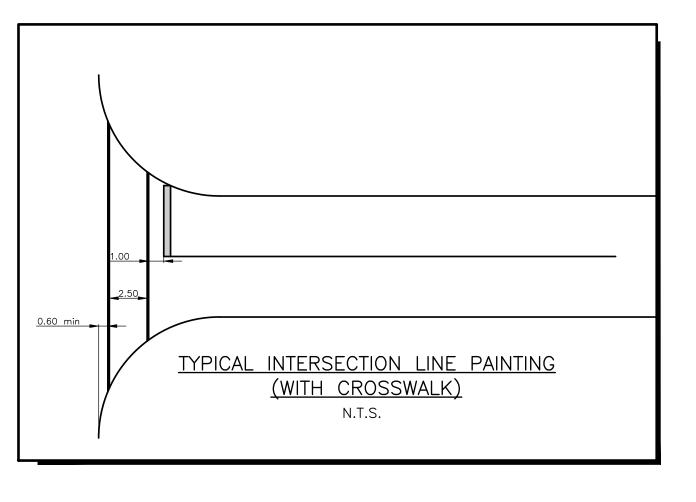

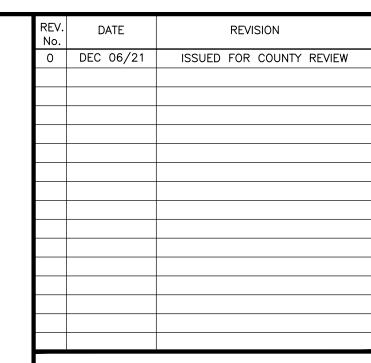

NOTE:
THE CONTRACTOR IS CAUTIONED THAT ALL OF THE EXISTING UTILITIES ARE NOT INDICATED ON THIS DRAWING. THE CONTRACTOR MUST ARRANGE FOR LOCATES FROM EACH AREA UTILITY COMPANY PRIOR TO ANY CONSTRUCTION OR EXCAVATION. THE CONTRACTOR SHALL BE SOLELY RESPONSIBLE FOR THE PROTECTION OF ALL UTILITIES INCLUDING THOSE NOT INDICATED ON THIS DRAWING. G. DOUGLAS VALLEE LTD. CAN NOT ACCEPT RESPONSIBILITY FOR DAMAGE TO ANY EXISTING UTILITY WHICH MAY OR MAY NOT BE INDICATED ON THIS DRAWING.



G. DOUGLAS VALLEE LIMITED 2 TALBOT STREET NORTH SIMCOE, ONTARIO N3Y 3W4 (519) 426-6270

Stamp

Project Title

COCKSHUTT ROAD SIDEWALK

PORT DOVER - NORFOLK COUNTY EIS-ENG-22-##

Drawing Title

GENERAL NOTES

Designed by:

NLB

NLB

Checked by:

TGS

Drawn By:

NL

NL

NL

Date Started:

SEPTEMBER 15, 202

Drawing Scale:

Drawing No.

AS SHOWN
Project No.

21-055-30

G